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Rev A	Planning Issue	AP	29/05/25
Revision Number	Revision Description	Issued by	Revision Date
DATE:	STATUS:	SHEET SIZE:	
09/03/25	PLANNING ISSUE	A1	
SCALE:	DRAWN:	CHECKED:	
1 : 100	AP		

SITE ADDRESS:
Land East of MG

REVISION:
Rev A

DRAWING NO.:
ARCI/088/25/01

PROJECT NO.:
LEM/C

New Build

Existing Floor Plans

ARCHEOLVE

design // design@archeolve.co.uk

WEB // www.archeolve.co.uk

07830 325566 //



0m 2m 4m 6m 8m 10m
VISUAL SCALE 1:100 @ A1



Appendix D

British Geological Society Borehole Records

F P Boreholes Limited		DRILL LOG						
Project:	Land off London Rd, Washington	Job No:	J1067		Equipment Used:			Dando 2500
Client:	NKR Property	Date:	09/09/2024					
Hole No:	BH01	Hole Dia.	Depth	Water at start of shift		Water added from		
		250mm	10M	Water at end of shift				None
		200mm	50M					
Depth	Strata	Samples	Type	No.	Well Details			
0 - 4.7	Soft to firm Mottled orange/ grey very fine sandy Clay				Cased to	3.0	In	250mm
4.7 -	Firm to Stiff dark grey fine to medium sandy clay with some sand patches and occasional extremely weakley to well cemented sand stone bands at depth.				Cased to	27.0	In	200mm
24.5					Open Hole from	27.0	To	50.0
24.5 -	stiff to very stiff dark green/ Grey clayey sand and sandy clay with occasional coarse black sands				Permanent Liner Details			
27.0					Liner size	113mm	Slot	1mm
27.0 -	Recovered as mid grey fine to coarse sand with occasional well cemented sandstone stone bands and interbedded clay bands.				Solid liner from	GL	To	27.0
50					Slotted liner from	27.0	To	49.0
					Open in Bedrock from	N/A	To	N/A
					Sump Used	49.0	To	50.0
					Seal Depth	28.0	Gravel used	3 to 6mm (soaked)
Pumping Details								
					Static water mbgl	11.0	12/11/2024	
					Pump used	Grundfos SQ2-75		
					Pump Depth	50.0		
					Pump Riser used	MDPE	Size	32mm
Pump Test								
					Litres per Hour	2000	Well pumped until water ran clear. Water starting Mid brown/ grey.	
					Time run	1 Hour		
					Water level at start	11.0		
					Water level at finish	11.0		
					Drawdown Level	11.8		
Bailer Test (CP)								
					Start level	11.0	10 x 200mm bailer	
					Finish Level	11.0		
Special Comments:								
Tool pinched in hole causing almost a 4 week delay. Tool retrieved and hole freed from blockage and continued. Steel Upright covers installed Well cleared and pump removed								
Remarks		Standing	Water Strike	Depth	5min	10min	15min	20min
Completed 18/10/24		Dayworks		4.2				
		Hand Pit	1	16.0				
		Slow Progress		Water at end of hole: 11.0				
		Chiseling						
Other Details:								

F P Boreholes Limited		DRILL LOG						
Project:	Land off London Rd, Washington	Job No:	J1067		Equipment Used:	Dando 2500		
Client:	NKR Property	Date:	23/10/2024					
Hole No:	BH02	Hole Dia.	Depth	Water at start of shift	Water added from			
		250mm	10M	Water at end of shift	None			
		200mm	50M					
Depth	Strata	Samples	Type	No.	Well Details			
0 - 4.5	Soft to firm Mottled orange/ grey very fine sandy Clay				Cased to	3.0	In	250mm
4.5 -	Firm to Stiff dark grey fine to medium sandy clay with some sand patches and occasional extremely weakly to well cemented sandstone bands at depth.				Cased to	12.0	In	200mm
25.5					Open Hole from	12.0	To	50.0
25.5 -	stiff to very stiff dark green/ Grey clayey sand and sandy clay with occasional coarse black sands				Permanent Liner Details			
27.5					Liner size	113mm	Slot	1mm
27.5 -	Recovered as mid grey fine to coarse sand with occasional well cemented sandstone stone bands and interbedded clay bands.				Solid liner from	GL	To	27.0
50					Slotted liner from	27.0	To	49.0
					Open in Bedrock from	N/A	To	N/A
					Sump Used	49.0	To	50.0
					Seal Depth	28.0	Gravel used	3 to 6mm (soaked)
Pumping Details								
					Static water mbgl	11.0	13/11/2024	
					Pump used	Grundfos SQ2-75		
					Pump Depth	50.0		
					Pump Riser used	MDPE	Size	32mm
Pump Test								
					Litres per Hour	2000	Well pumped until water ran clear. Water starting Mid brown/ grey.	
					Time run	1 Hour		
					Water level at start	10.6		
					Water level at finish	10.6		
					Drawdown Level	11.0		
Bailer Test (CP)								
					Start level	10.6	10 x 200mm bailer	
					Finish Level	10.6		
Special Comments:								
Steel Upright covers installed Well cleared and pump removed								
Remarks		Standing	Water Strike	Depth	5min	10min	15min	20min
Completed 12/11/24		Dayworks		4.5				
		Hand Pit	1	17.0				
		Slow Progress		Water at end of hole:				10.6
		Chiseling						
Other Details:								


Appendix E

Watercourse Connectivity



Appendix F

Southern Water Asset Location Plan

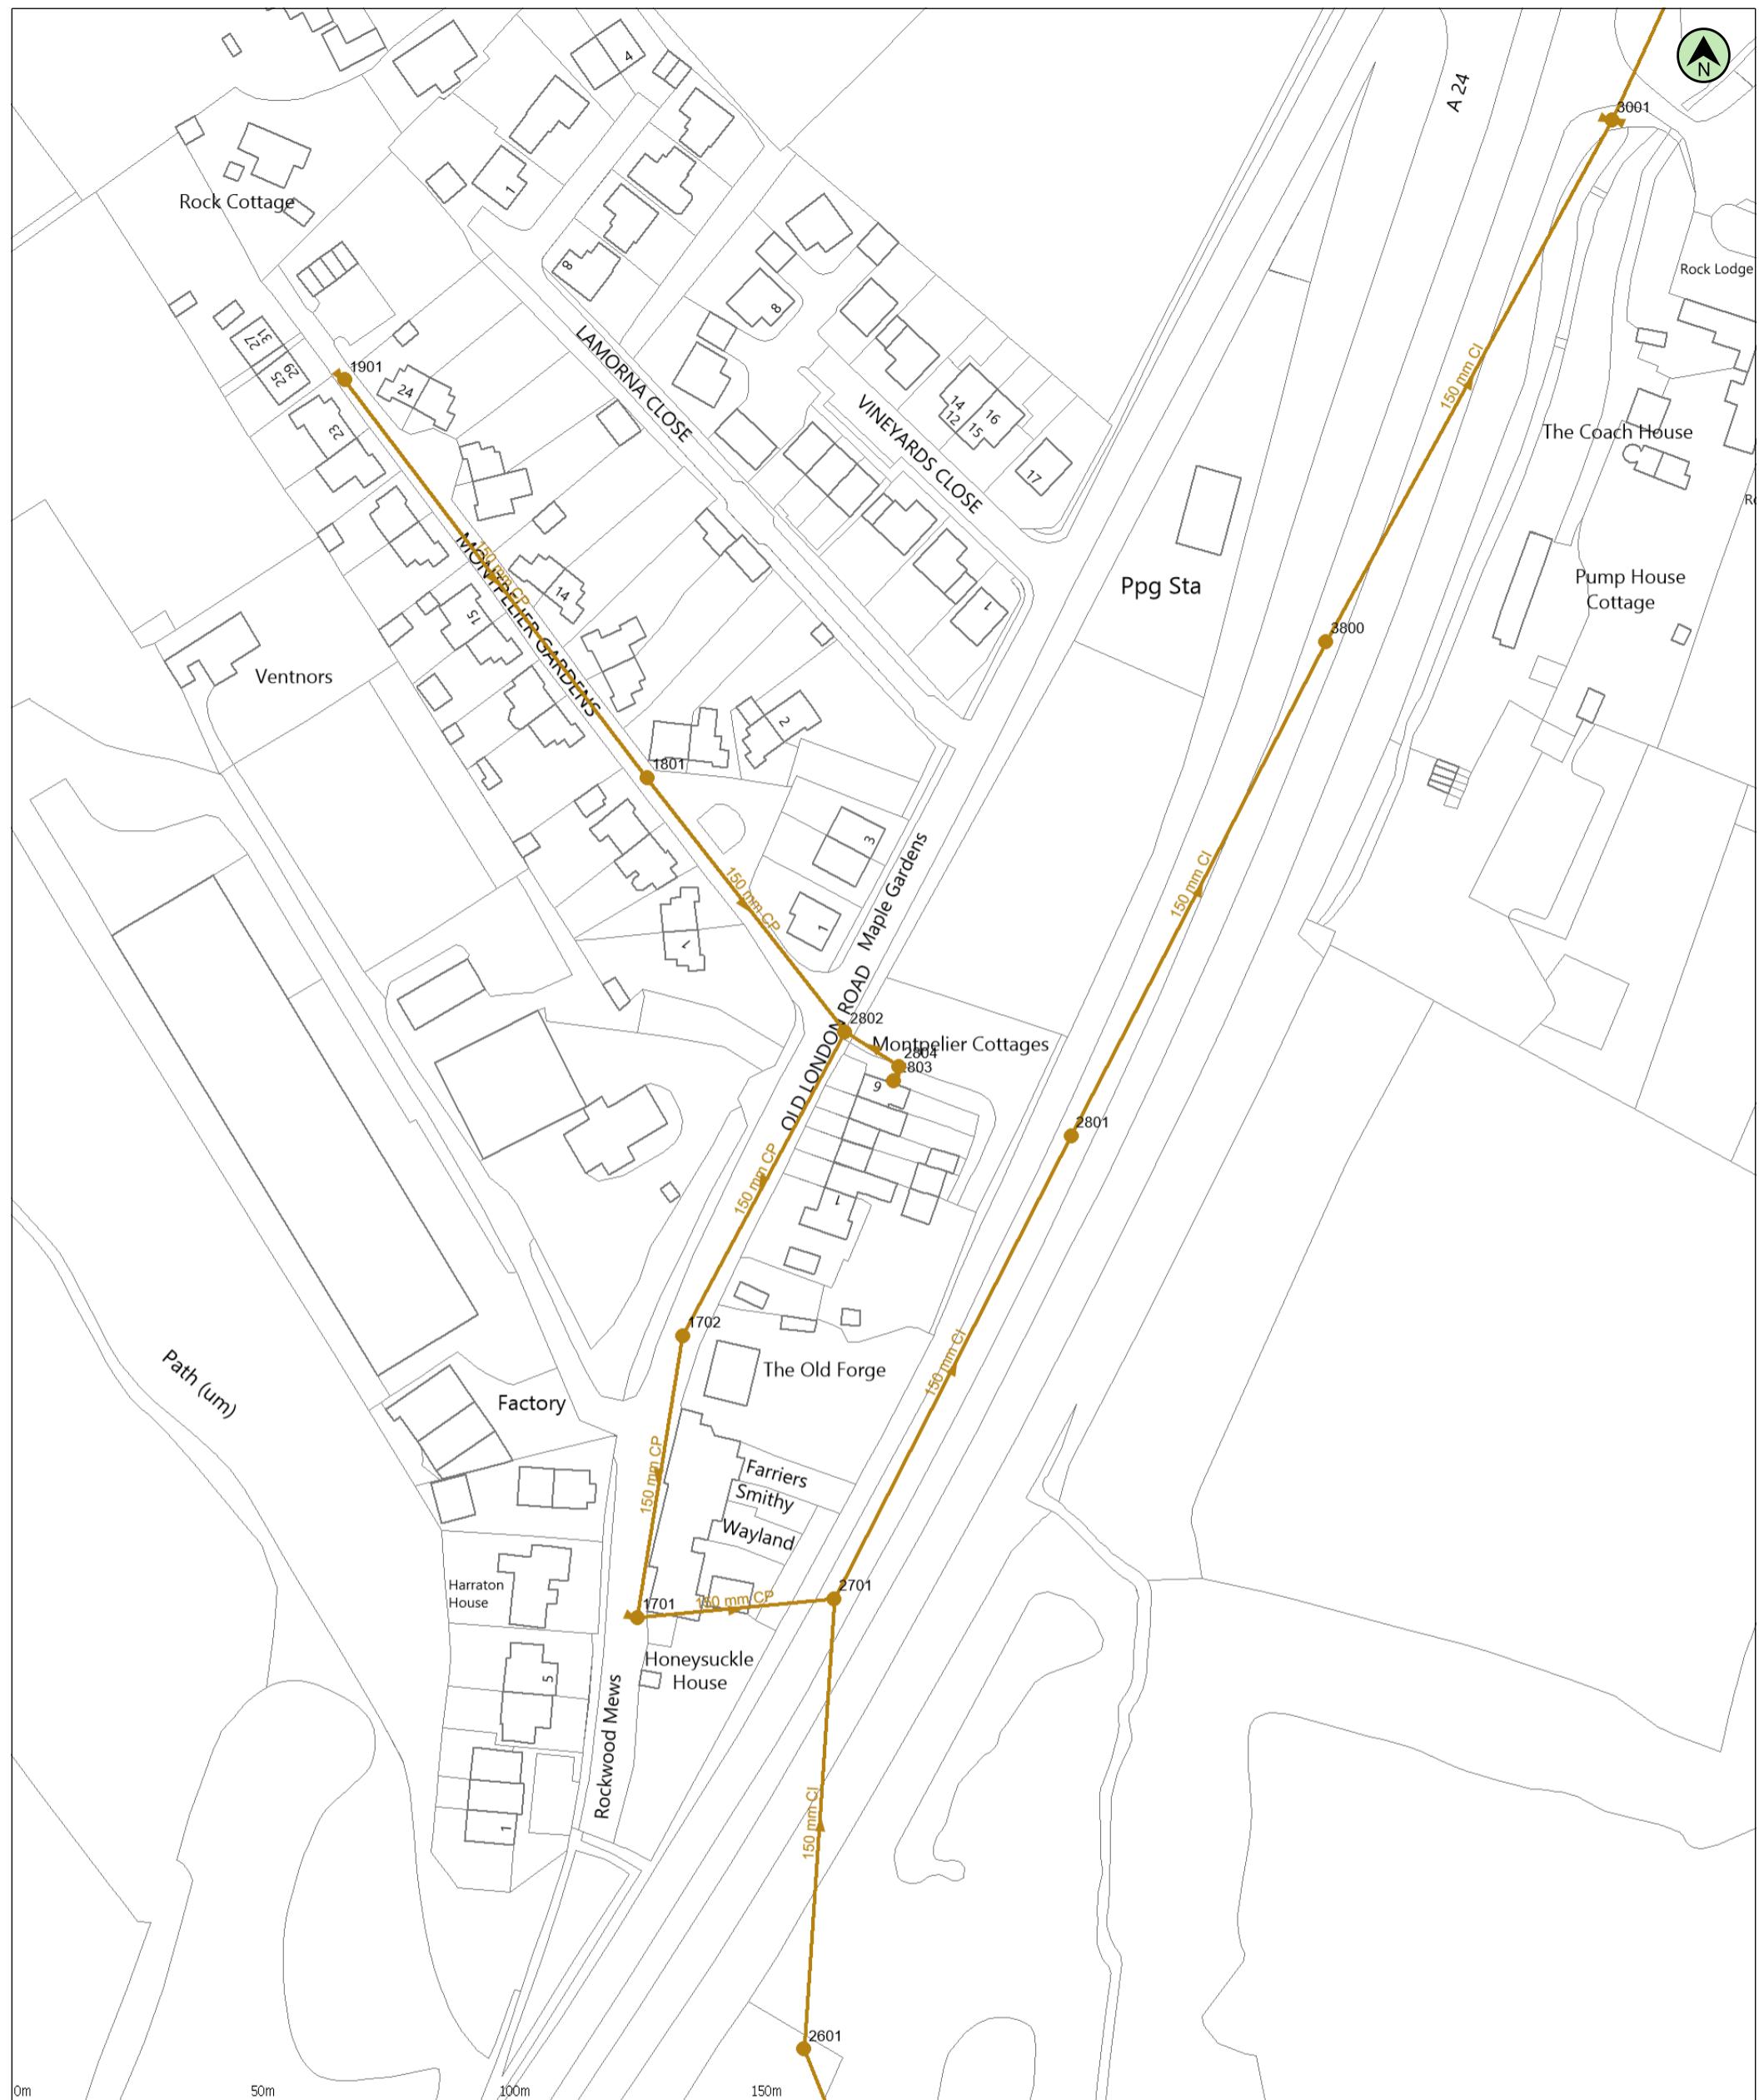


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Data updated: 20/05/25

Scale: 1:1250
Map Centre: 512236, 113816

Date: 20/06/25
Our Ref: 1804474 - 1

Wastewater Plan A3
Powered by digitat

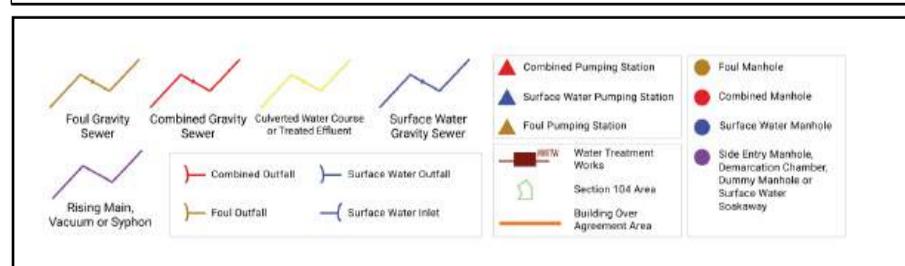

pallen@motion.co.uk
Old London Road



from
Southern
Water

The positions of pipes shown on this plan are believed to be correct, but Southern Water Services Ltd accept no responsibility in the event of inaccuracy. The actual positions should be determined on site. This plan is produced by Southern Water Services Ltd (c) Crown copyright and database rights 2025 Ordnance Survey AC0000808122. This map is to be used for the purposes of viewing the location of Southern Water plant only. Any other uses of the map data or further copies is not permitted.

WARNING: BAC pipes are constructed of Bonded Asbestos Cement.

WARNING: Unknown (UNK) materials may include Bonded Asbestos Cement.

Appendix G

NaFRA2 Environment Agency Flood Map for Planning

Flood map for planning

Your reference
Unspecified

Location (easting/northing)
512250/113815

Created
20 June 2025 11:08

Your selected location is in flood zone 1, an area with a low probability of flooding.

You will need to do a flood risk assessment if your site is **any of the following**:

- bigger than 1 hectare (ha)
- in an area with critical drainage problems as notified by the Environment Agency
- identified as being at increased flood risk in future by the local authority's strategic flood risk assessment
- at risk from other sources of flooding (such as surface water or reservoirs) and its development would increase the vulnerability of its use (such as constructing an office on an undeveloped site or converting a shop to a dwelling)

Notes

The flood map for planning shows river and sea flooding data only. It doesn't include other sources of flooding. It is for use in development planning and flood risk assessments.

This information relates to the selected location and is not specific to any property within it. The map is updated regularly and is correct at the time of printing.

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Flood map for planning

Your reference
Unspecified

Location (easting/northing)
512250/113815

Scale
1:2,500


Created
20 Jun 2025 11:08

- Selected area
- Flood zone 3
- Flood zone 2
- Flood zone 1
- Flood defence
- Main river
- Water storage area

0 20 40 60m

Appendix H

NaFRA2 Risk of Flooding from Surface Water (RoFSW) Mapping

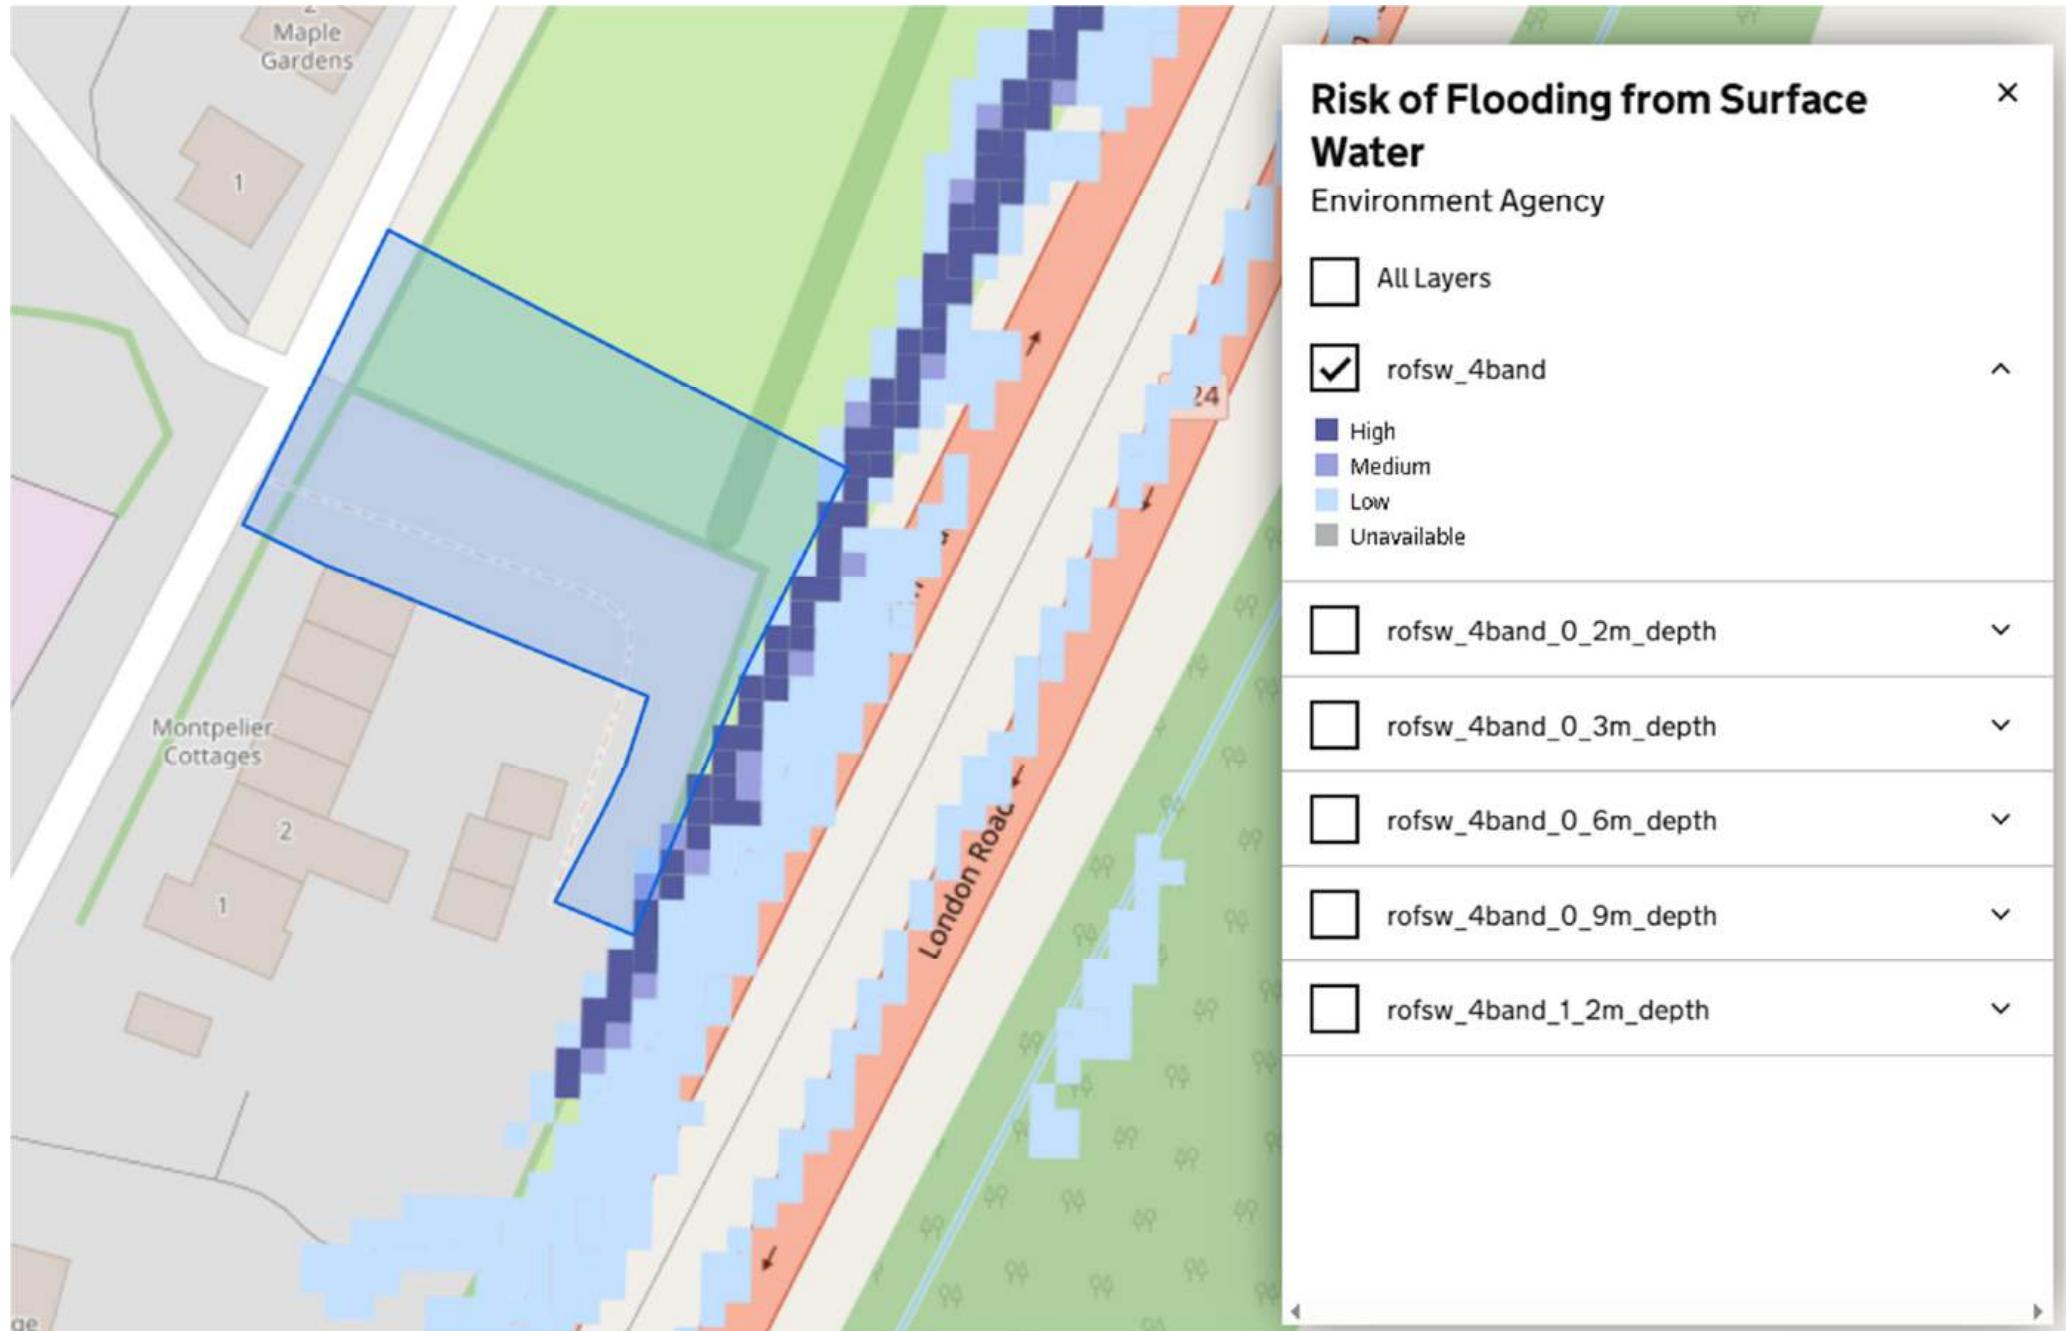

Appendix I

Horsham District Council SFRA Areas Subject to Groundwater Flooding Maps